### ARCHAEOLOGICAL NOTE:

IN THE EVENT THAT HUMAN REMAINS AND/OR CULTURAL MATERIALS ARE FOUND, ALL PROJECT-RELATED CONSTRUCTION SHALL CEASE WITHIN A 100-FOOT RADUS. THE CONTRACTOR SHALL, PURSUANT TO SECTION 7505.5 OF THE HEALTH AND SAFETY CODE, AND SECTION 5097.94 OF THE PUBLIC RESOURCES CODE OF THE STATE OF CALIFORNIA, NOTIFY THE UNIVESTITY REPRESENTATIVE WIMEDIATELY.

### STANDARD GRADING NOTES:

- 1. ALL GRADING ACTIVITIES, INCLUDING EXCAVATION, BACKFILL AND COMPACTION, SHALL BE DONE IN ACCORDANCE WITH THE GEOTECHNICAL SITE INVESTIGATION REPORT PREPARED FOR THIS PROJECT.
- ALL EXCESS SOIL SHALL BE OFF-HAULED TO A LEGAL DISPOSAL SITE. NO EXCESS SOIL SHALL BE SPREAD ON THE SITE WITHOUT CLEARLY BEING SHOWN ON THE APPROVED GRADING PLAN, OR AS APPROVED BY THE OWNER.

### CONTRACTOR RESPONSIBILITY:

CONTRACTOR AGREES THAT HE SHALL ASSUME SOLE AND COMPLETE RESPONSIBILITY FOR JOB SITE CONDITIONS, INCLUDING THE SAFETY OF ALL PERSONS AND PROPERTY DIRING THE COURSE OF CONSTRUCTION OF THIS PROJECT, AND THAT THIS REQUIREMENT SHALL APPLY CONTRINUOUSLY AND NOT BE LIMITED TO NORMAL WORKING HOURS. THE CONTRACTOR SHALL DEFEND, INDEMNIFY AND HOLD THE OWNER AND THE ENGINEER HABMLESS FROM ANY AND ALL LIABULTY, REAL OR ALLECED, IN CONNECTION WITH THE PERFORMANCE OF WORK ON THIS PROJECT, EXCEPTING FOR LIABULTY ARISING FROM THE SOLE NEGLIGIBLE OF THE OWNER OR THE ENGINEER.

IF THERE ARE ANY DISCREPANCIES BETWEEN DIMENSIONS IN DRAWINGS AND EXISTING CONDITIONS WHICH MILL AFFECT THE WORK, THE CONTRACTOR SHALL BRING SUCH DISCREPANCIES TO THE ATTENTION OF THE ENGINEER FOR ADJUSTMENT BEFORE PROCEEDING WITH THE WORK, THE CONTRACTOR SHALL BE RESPONSIBLE FOR THE

MAP NUMBER: 22-11-04052-0101
ACREAGE: 5.31 ASSESSOR'S RECORDS,
4.89 SURVEY
WATER SOURCE: SNOQUALMIE PUBLIC UTILITY DIST.
SEKER SOURCE: SNOQUALMIE PUBLIC UTILITY DIST.
ZONE: PLANNED UNIT DEVELOPMENT
LAND USE: RURAL

BOUNDARY AND TOPOGRAPHY SURVEY BY GROUP 4. PROJECT NO. 07–4048. BOUNDARY AND TOPOGRAPHIC INFORMATION SHOWN IS FOR REFERENCE ONLY, AND HAS NOT BEEN VERIFED IN THE FIELD.

### BASIS OF BEARINGS:

SHOQUALMIE SUMMIT INN SHORT PLAT, PER RECORD OF SURVEY RECORDED IN VOL. 16, PAGES 11–13, RECORDS OF KITIITAS COUNT, WASHINGTON

NAVO 88
WASHINGTON DEPARTMENT OF TRANSPORTATION CONTROL POINT
NO. 5161. BRASS DISC IN ROUND CONCRETE MONUMENT IN CASE
SET LEVEL WIOTH GROUND SURFACE. ELEVATION=2986.85'

SITE BENCH:

TBM 1: YELLOW CAPPED REBAR AT SW CORNER TRACT E, AS SHOWN ON MAP. ELEVATION=3008.12 TBM 2: YELLOW CAPPED REBAR AT ANGLE POINT CORNER PARCEL B AS SHOWN ON MAP. ELEVATION=3021.12

## PROPERTY INFORMATION:

368135, 378135, 388135, 398135, 408135, 418135

PROJECT SIZE: 57,630 SF (1.32 ACRES)

PROJECT ADDRESS:

LAMIRD'S TYPE 1

WATER/SEWER: SNOQUALMIE PASS UTILITY DISTRICT

## PROJECT TEAM:

APPLICANT/OWNER:

IAN LOVELESS SNOPASS SF LOFTS LLC 401 N 36TH STREET, SUITE 201 SEATTLE, WA 98101 (425) 404-1811


COSTA PHILIPPIDES, PE ENCOMPASS ENGINEERING & SURVEYING 165 NE JUNIPER STREET, SUITE 201 ISSAQUAH, WA 98027 (425) 392-0250

GEOTECHNICAL ENGINEER:


SHANE MARKUS ICICLE CREEK ENGINEERS, INC 29335 NE 20TH STREET (425) 333-0093

- PRIOR TO ANY CONSTRUCTION ACTIVITY, THE CONTRACTOR SHALL SCHEDULE AND ATTEND A PRE-CONSTRUCTION MEETING WITH THE COUNTY, UTILITY DISTRICT AND THEIR REPRESENTATIVE. THE CONTRACTOR SHALL NOTIFY ENCOMPASS ENGINEERING OF THE PRE-CONSTRUCTION MEETING THE AND LOCATION.
- PAVED SURFACES INCLUDING ROADWAYS, SIDEWALKS AND CURBS THAT ARE DAMAGED BY NEW CONSTRUCTION SHALL BE REPAIRED AS REQUIRED BY THE INSPECTOR.
- ALL SURVEYING AND STAKING OF IMPROVEMENTS SHALL BE APPROVED BY THE DEVELOPER. CONTRACTOR SHALL COORDINATE AND VERIFY WITH THE DEVELOPER PRIOR TO OBTAINING STAKING SERVICES.
- THE CONTRACTOR SHALL MOTIFY THE KITTITAS COUNTY FIRE DISTRICT (509-386-1495) TWENTY-FOUR (24) HOURS IN ADVANCE OF ALL WATER SERVICE INTERPLIPTIONS, WIDPART SHIVE-OFFS, AND STREET CLOSURES OR OTHER ACCESS BLOCKAGE. THE CONTRACTOR SHALL ALSO NOTIFY THE DISTRICT OF ALL NEW, RELOCATED, OR ELIMINATED HYDRANTS RESULTING FROM THIS WORK.
- 8. THE CONTRACTOR SHALL LOCATE AND PROTECT ALL ACTIVE CASTINGS AND UTILITIES DURING CONSTRUCTION AND SHALL CONTACT THE UNDERGROUND UTILITIES LOCATOR SERVICE (1–800–424–5555) AT LEAST 48 HOURS PRIOR TO CONSTRUCTION.
- D. THE CONTRACTOR SHALL ADJUST ALL EXISTING MANHOLE RIMS, DRAINAGE STRUCTURE LIDS, VALVE BOXES AND UTILITY ACCESS STRUCTURES TO FINISH GRADE WITHIN AREAS AFFECTED BY THE PROPOSED IMPROVEMENTS. THE CONTRACTOR SHALL PROVIDE FOR ALL COMPACTION TESTS REQUIRED BY THE INSPECTOR.
- WATER OILDIES MILL BE ACCOMPLISTED BY SURQUALME PASS OFFICE OF DISTRICT. IT SHALL BE THE CONTRACTORS RESPONSIBILITY TO COORDINATE AND SOCIEDUE APPROPRIATE INSPECTIONS, ALLOMING PROPER ADVANCE NOTICE. THE INSPECTION MAY REQUIRE RECONSTRUCTION OF ITEMS THAT DO NOT MEET THE CONTRACT DOCUMENTS OR THAT MERE CONSTRUCTED WITHOUT INSPECTION.
- THE CONTRACTOR SHALL PROMDE AND MAINTAIN BEST MANAGEMENT PRACTICES AS SHOWN HEREIN TO RISURE THAT SEDMENT—LADEN WATER DOES NOT ENTER THE WATER OF THE STATE. AS CONSTRUCTION PROGRESSES AND UNEXPECTED (SEASONAL) CONDITIONS DUCTATE, ADDITIONAL BEST MANAGEMENT PRACTICES MAY BE REQUIRED. THEREFORE, DURING THE COURSE OF CONSTRUCTION IT SHALL BE THE OBLIGATION AND RESPONSIBILITY OF THE CONTRACTOR TO ADDRESS MAY NEW CONDITIONS THAT MAY BE CREATED BY HIS ACTIVITIES AND TO PROVIDE ADDITIONAL FACILITIES THAT MAY BE NEEDED TO PROTECT ADJACENT PROPERTIES.
- 4. THE CONTRACTOR SHALL KEEP ALL STREETS AND PUBLIC RIGHT-OF-WAY CLEAN AT ALL TIMES BY SWEEPING. WASHING WILL NOT BE ALLOWED WITHOUT PRIOR APPROVAL BY THE COUNTY OR ENGINEER.
- CONTRACTOR SHALL PROVIDE TRAFFIC CONTROL AS NECESSARY THROUGHOUT THE PROJECT. TRAFFIC CONTROL SHALL BE IN ACCORDANCE WITH WISDOT AND KITITAS COUNTY STANDARDS.
- CONTRACTOR SHALL COORDINATE ALL ELECTRICAL WORK WITH PSE AND ELECTRICAL CONSULTANT.

- THE CONTRACTOR SHALL BE RESPONSIBLE FOR PROVIDING ADEQUATE SAFEGUARDS, SAFETY DEVICES, PROTECTIVE EQUIPMENT, FLAGGERS, AND ANY OTHER NEEDED ACTIONS TO PROTECT THE LIFE, HEALTH, AND SAFETY OF THE FUELD, AND TO PROTECT PROPERTY IN CONNECTION WITH THE PERFORMANCE OF WORK COVERED BY THE CONTRACTOR. ANY WORK WITHIN THE TRAVELED RIGHT—OF—MAY THAT MAY NIFERRIPLY NORMAL TRAFFIC FLOW SHALL REQUIRE AT LEAST ONE FLAGGER FOR EACH LANE OF TRAFFIC AFFECTED. ALL SECTIONS OF THE WSDOT STANDARD SPECIFICATIONS 1—07.23 TRAFFIC CONTROL, SHALL APPLY.
- ANY TRENCH DEEPER THAN 5 FEET WILL REQUIRE SHORING FOR TRENCH WALL STABILIZATION.

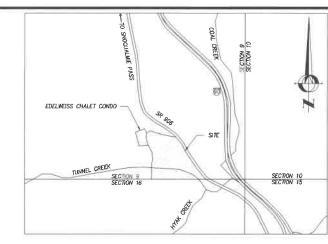

VICINITY MAP

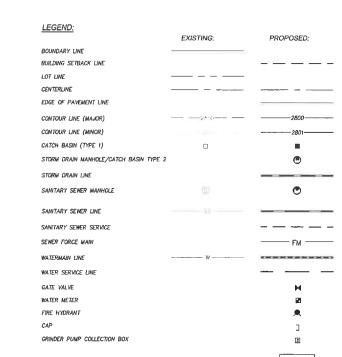

## CONCRETE HATCH ECEIVE

MAR 0 9 2022

# Kittitas County CDS

SHEET INDEX:				
TITLE	SHEET			
COVER SHEET	1			
TEMPORARY EROSION CONTROL PLAN	2			
TESC NOTES AND DETAILS	3			
GRADING PLAN	4			
JTILITY PLAN	5			
CONSTRUCTION DETAILS AND PROFILES	6			
UTILITY DETAILS	7			
JTILITY DETAILS	8			
UTILITY DETAILS	9			
SNOW STORAGE PLAN	10			

### **KITTITAS COUNTY**

APPROVED FOR CONSTRUCTION

DATE DIRECTOR OF PUBLIC WORKS








03/08/202

LOTS SHEE **ESTATES** 

ACRES SKI

> **\(\rapprox\_{\bar{p}}\)** OMD ERING & SURVI

20264 03/08/202 SCALE 1"=40" 1WD DRAWN CHECKEL SHEET

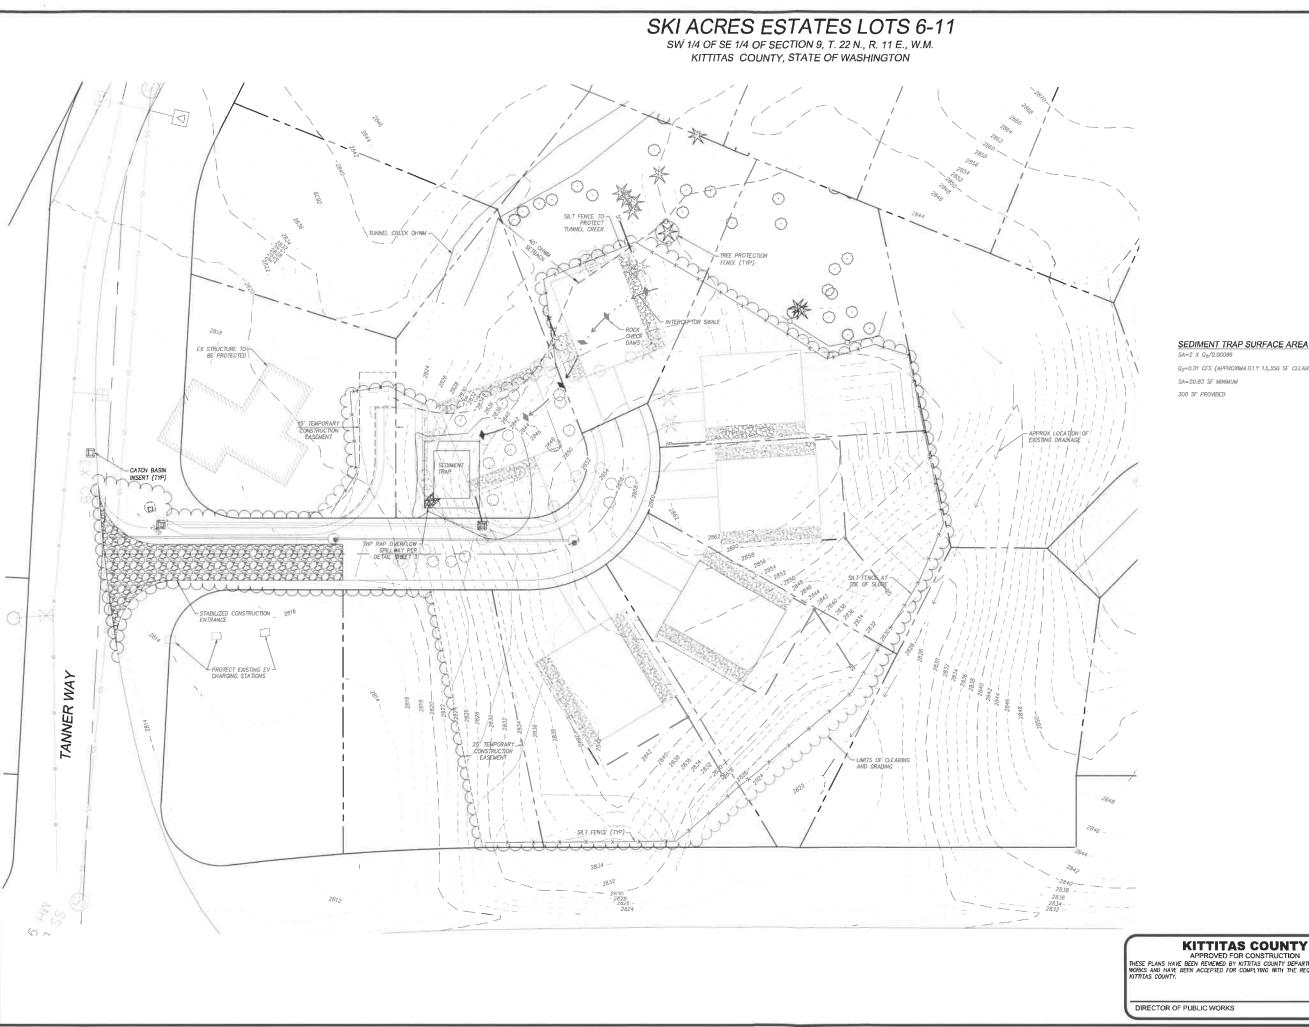



## SEDIMENT TRAP SURFACE AREA CALCULATION

Q2=0.01 CFS (APPROXIMATELY 13,350 SF CLEARED AREA TRIBUTARY) SA=20.83 SF MINIMUM

APPROVED FOR CONSTRUCTION
THESE PLANS HAVE BEEN REVIEWED BY MITTING COUNTY DEPARTMENT OF PUBLIC WORKS AND HAVE BEEN ACCEPTED FOR COMPLYING WITH THE REQUIREMENTS OF INTITIAS COUNTY.

DATE







PLAN SKI ACRES ESTATES LOTS 6-11 TEMPORARY EROSION CONTROL

Encompass ENGINEERING & SURVEYING

NO.	20264
Έ	03/08/2022
LE	1"=30'
IGNED	IWD
WN	TNF
CKED	CP
ROVED	CP

SW 1/4 OF SE 1/4 OF SECTION 9, T. 22 N., R. 11 E., W.M. KITTITAS COUNTY, STATE OF WASHINGTON

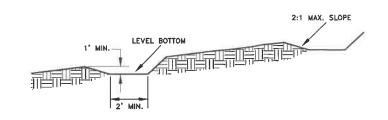

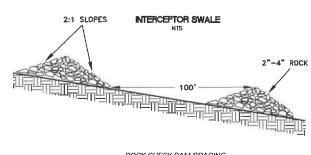

ROCK CHECK DAM SPACING NTS

FILTER FABRIC

-2"x2" WOOD POSTS, STEEL FENCE POSTS, REBAR, OR EQUIVALENT

- SILT FENCE MAINTENANCE PER 2009 KCSMOM

  1. ANY DAMAGE SHALL BE REPARED IMMEDIATELY.

  2. IF CONCENTRATED FLOWS ARE EVIDENT UPHALL OF THE FENCE, THEY MUST BE INTERCEPTED AND CONVEYED TO A SEDMENT TRAP OR POND.


  3. IT IS MAPORTANT TO CHECK THE UPHALL SIDE OF THE FENCE FOR SIGNS OF THE FENCE CORGING AND ACTING AS A BARRIER TO FLOW AND THEN CAUSING CHANNELIZATION OF FLOWS PARALLEL TO THE FENCE. IF THIS OCCURS, REPLACE THE FENCE OR REMOVE THE TRAPPED SEDMENT.

  4. SEDMENT MUST BE REMOVED WHEN THE SEDMENT IS 6 INCHES HIGH.

  5. IF THE FITTER FABRIC (GEOTEXTILE) HAS DETERIORATED DUE TO ULTRAMOLET BREAKDOWN, IT SHALL BE REPLACED


SILT FENCE NTS

POST SPACING MAY BE INCREASED TO B' IF WIRE BACKING IS USED

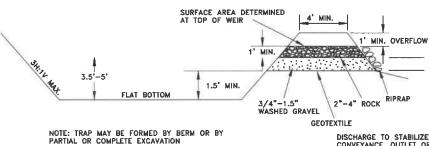


DISCHARGE TO STABILIZED CONVEYANCE, OUTLET OR LEVEL SPREADER


CROSS SECTION

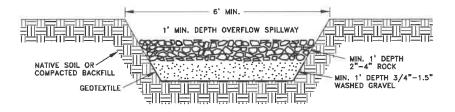

SEDIMENT TRAP OUTLET

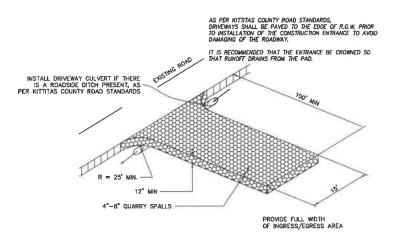

STABILIZED CONSTRUCTION ENTRANCE
NTS

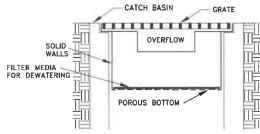

NOTE: THIS DETAIL IS ONLY SCHEMATIC. ANY INSERT IS ALLOWED THAT HAS A MIN. 0.5 C.F. OF STORAGE, THE MEANS TO DEWATER THE STORED SEDIMENT, AN OVERFLOW, AND CAN BE EASILY MAINTAINED.

CATCH BASIN INSERT



APPROVED FOR CONSTRUCTION
THESE PLANS HAVE BEEN REVIEWED BY KITHTAS COUNTY DEPARTMENT OF PUBLIC
WORKS AND HAVE BEEN ACCEPTED FOR COMPLYING WITH THE REQUIREMENTS OF
KITHTAS COUNTY.

DIRECTOR OF PUBLIC WORKS

Know what's below. DATE Call before you dig.






6-11 SKI ACRES ESTATES LOTS

TESC NOTES AND DETAILS

2 INCOMPANIO ENGINEERING & SURVEYING

03/08/2022 NTS IWD TNF CP DESIGNED CHECKED APPROVED 3

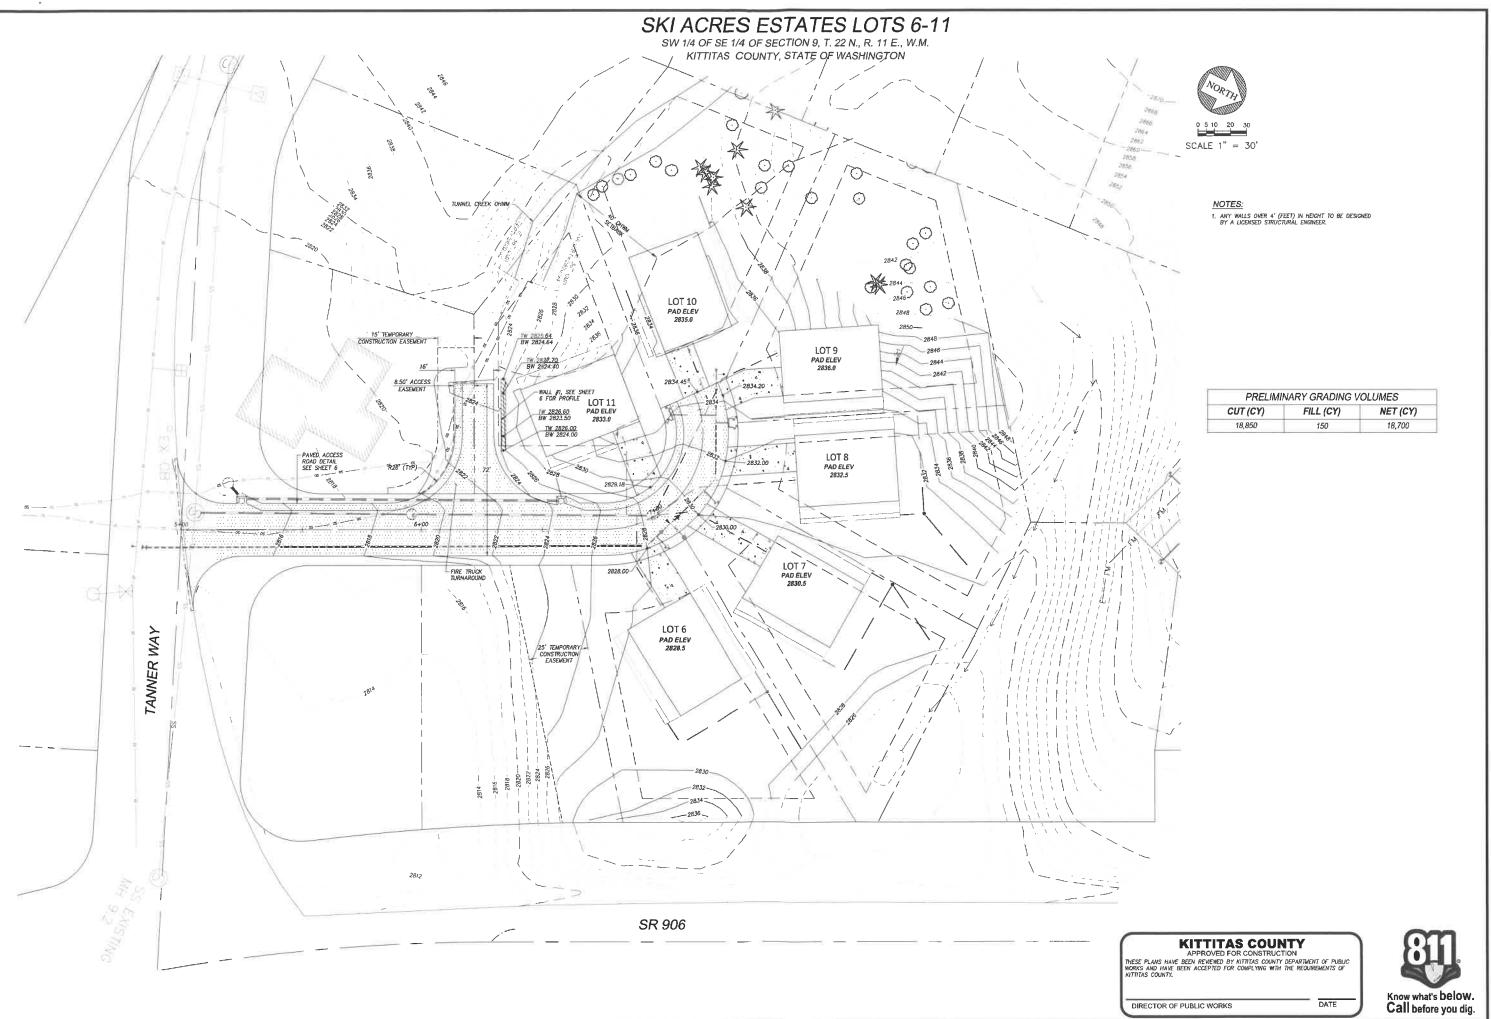




6-11

SKI ACRES ESTATES LOTS 6. SNOPASS SFLOFTS LLC GRADING PLAN

Encompass

DESIGNED DRAWN CHECKED APPROVED

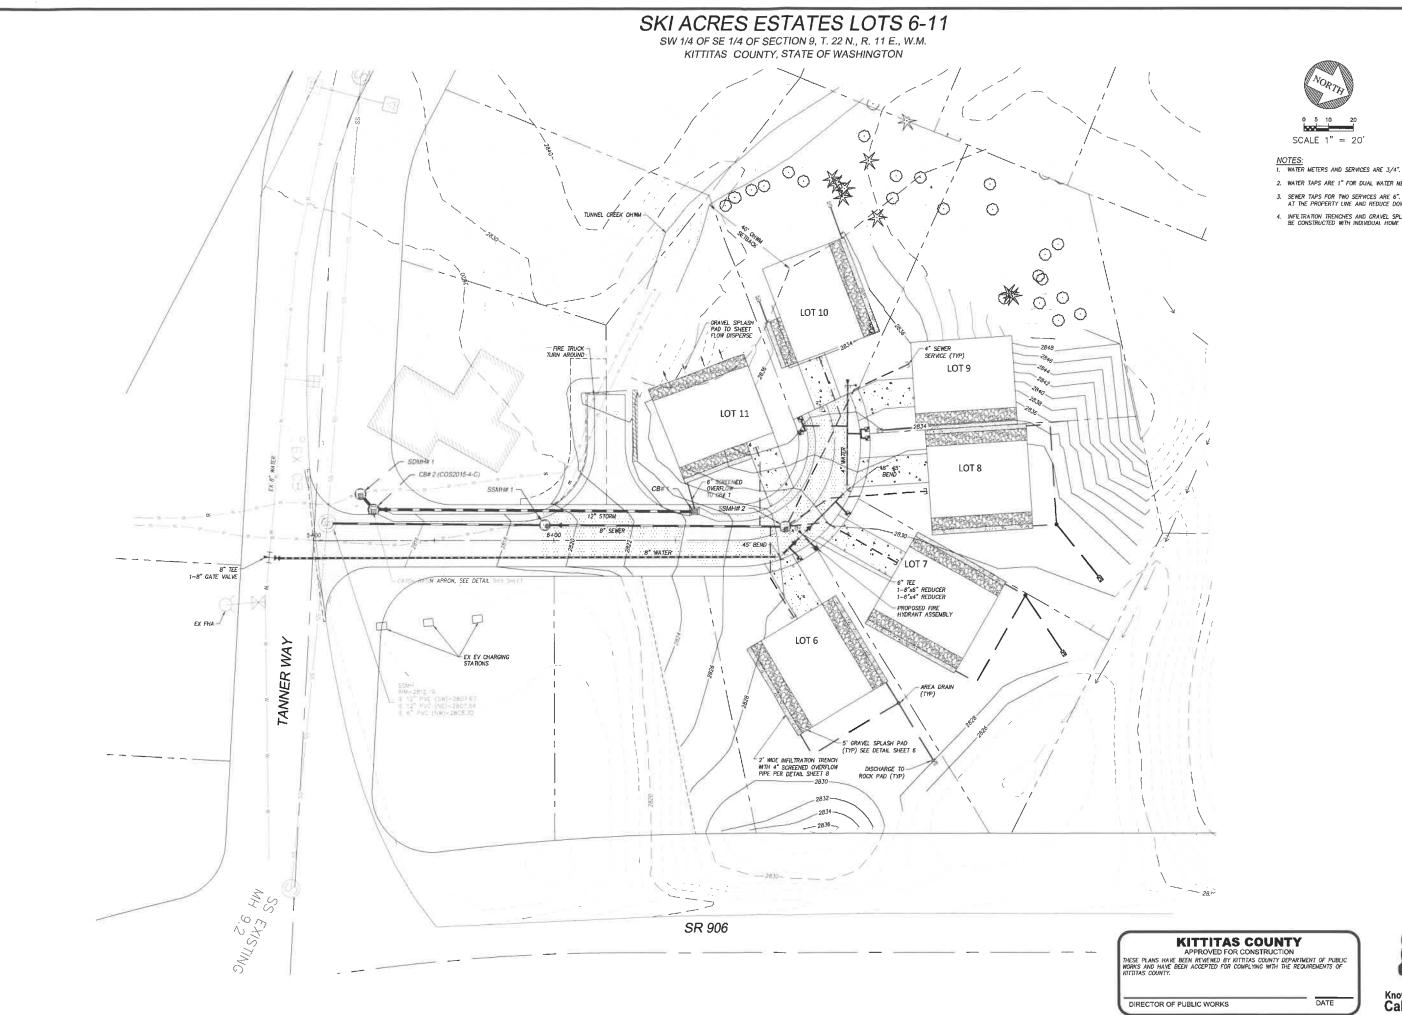



- . INFILTRATION TRENCHES AND GRAVEL SPLASH PADS TO BE CONSTRUCTED WITH INDIVIDUAL HOME CONSTRUCTION.




6-11 SKI ACRES ESTATES LOTS SNOPASS SF LOFTS LLC UTILITY PLAN

2) Encompass engineering a squeening

20264 03/08/2022 1"=30' IWD TNF CP CP DRAWN CHECKED APPROVED 5

Know what's below. Call before you dig.


SW 1/4 OF SE 1/4 OF SECTION 9, T. 22 N., R. 11 E., W.M. KITTITAS COUNTY, STATE OF WASHINGTON

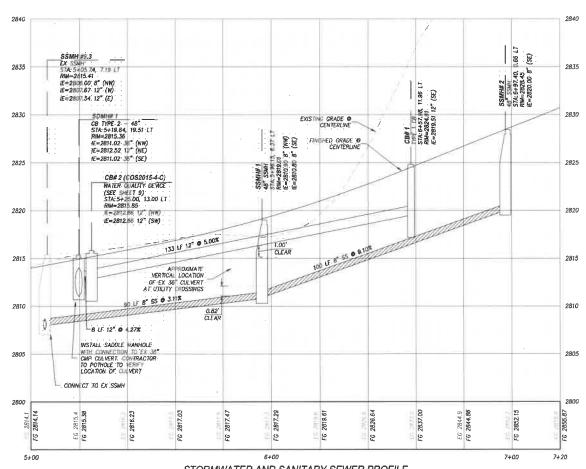



STORMWATER AND SANITARY SEWER PROFILE

SCALE: HORIZ 1"= 20"


VERT. 1"= 5"

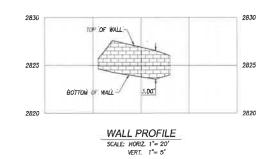


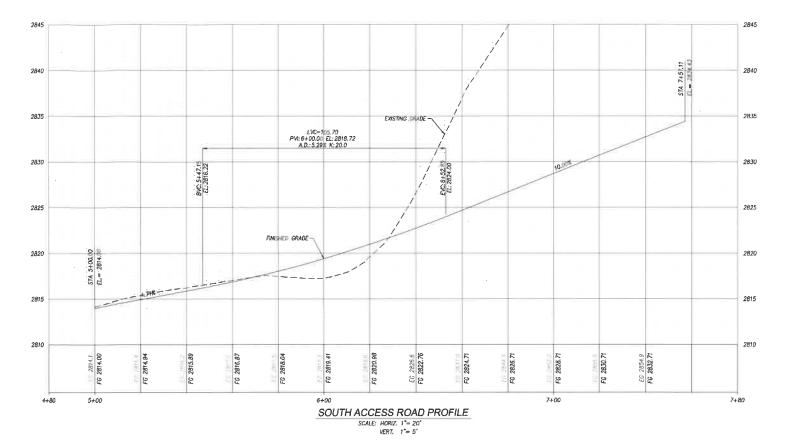

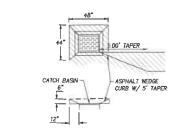

ASPHALT CURB CATCH BASIN APRON DETAIL

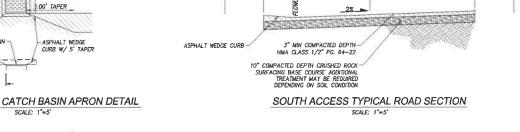

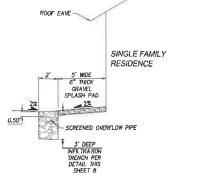

TYPICAL ROOFTOP RUNOFF INFILTRATION SYSTEM SCALE: 1"=5"



DATE

DIRECTOR OF PUBLIC WORKS

11' LANE

Know what's below. Call before you dig.





03/08/2022

CONSTRUCTION DETAILS AND PROFILES 6-11 SKI ACRES ESTATES LOTS

Encompas, encineering a spreming

20264 03/08/2022 NTS IWD TNF CP CP APPROVED 6 SHEET

**SEWER STANDARD DETAIL** 

**SNOQUALMIE PASS** 

**UTILITY DISTRICT** 

FILE SCALE DATE

SPUDTS1 NTS 7/22/04

**GENERAL MISCELLANEOUS DETAILS** 

**WATER STANDARD DETAIL** 

**SNOQUALMIE PASS** 

UTILITY DISTRICT

FILE SCALE DATE

SPUDTW12 NTS 7/22/04

**CLEANOUT** 

**SEWER STANDARD DETAIL** 

**SNOQUALMIE PASS** 

**UTILITY DISTRICT** 

FILE SCALE DATE
SPUDTS2 NTS 7/22/04

REVISIONS BY DATE

REPROMETER COMMENTS DO 03/09/202

REPROMETER COMMENTS DO 03/09/202

REPROMETER ON THIS SEET MEE AND SMILL REPROPERTY



03/08

ACRES ESTATES LOTS 6-11 snopass SFLOFTS LLC

UTILITY DETAILS

ENGINEERING & SURVEYING
WASTEN WASHING DASKON. W. Solden WASHING WASOZY Phone: (425) 192-0250

l	
JOB NO.	20264
DATE	03/08/202
SCALE	NTS
DESIGNED	IWD
DRAWN	TNF
CHECKED	CP
APPROVED	CP
SHEET	7

Know what's below.


Call before you dig.

**KITTITAS COUNTY** 

DIRECTOR OF PUBLIC WORKS

DATE

SW 1/4 OF SE 1/4 OF SECTION 9, T. 22 N., R. 11 E., W.M. KITTITAS COUNTY, STATE OF WASHINGTON

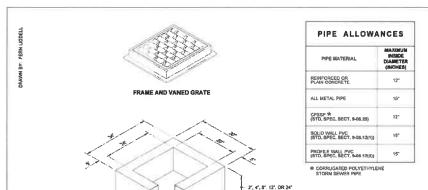

ONE #3 BAR FOR 6" (IN) HEIGHT INCREMENT (SPACED EQUALLY)

63 BAR HOOP

TY OAP

FILE SCALE DATE
SPUDTSS NTS 7/22/04

**BUILDING CONNECTION** 

ALTERNATIVE PRECAST BASE SECTION


- 1 As acceptable alternatives to the rebar shown in the PRECAST BASE SECTION. Reers (bleed according to the Standard Specifications), or wire mesh having a minimum area of 0.12 square inches per foot shall be used with the minimum required rebar shown in the ALTERNATIVE PRECAST BASE SECTION. Wire mesh shall not be placed in the knockouts.
- The knockout diameter shall not be greater than 20" (in). Knockouts shall have a wall thickness of 2" (in) minimum to 2.5" (in) maximum. Provide a 1.5" (in) minimum gap between the knockout wall and the outside of the pipe. After the pipe is installed, fill the gap with joint morter in accordance with Standard Specification Section 9-04.3.
- The maximum depth from the finished grade to the lowest pipe invert shall be 5' (ft).
- The frame and grate may be installed with the flange down, or integratly cast into the adjustment section with flange up.
- 6. The opening shall be measured at the top of the Precast Base Section

SHEET 1 OF 1 SHEET

Roark, Steve Date: John Steve Date: John Steve

Washington Spie Department of Transportation

7. All pickup holes shall be grouted full after the basin has been placed.

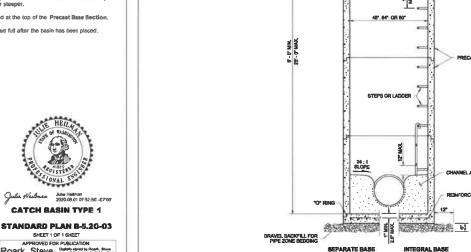

### NOTES

- 1. Knockouts shall have a wall thickness of 2" minimum to 2.5" maximum
- nces, see Standard Plan B-10.20.

MANHOLE DIMENSION TABLE				
DIAM.	MALL THICKNESS	MIN. BASE THICKNESS	MAXIMUM KNOCKOUT SIZE	MINIMUM DISTANCE BETWEEN KNOCKOUTS
48°	4"	6°	36°	8"
54°	4.5"	8*	42°	8"
60"	5"	8"	48°	8°




STANDARD PLAN 8-15.20-01

Pasco Bakutich III 02-07-12



SHEET 1 OF 1 SHEET

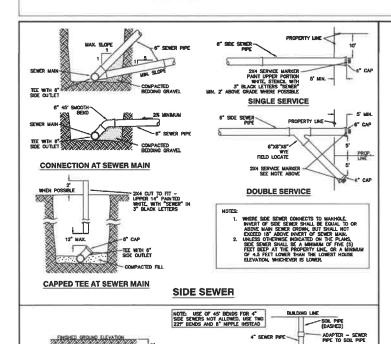

**HOUSE SEWER** 

**SEWER STANDARD DETAIL** 

**SNOQUALMIE PASS** 


**UTILITY DISTRICT** 

PRECAST BASE SECTION

#3 BAR HOOF

#3 BAR FACH WAS

**TESTING TEE - ELEVATION** 

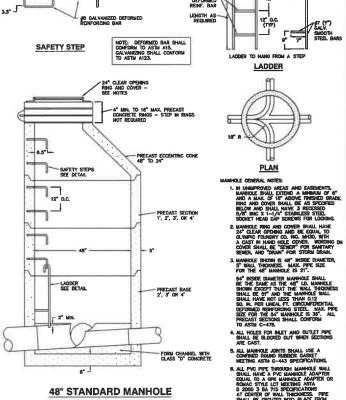


**SEWER STANDARD DETAIL** 

**SNOQUALMIE PASS** 

**UTILITY DISTRICT** 

FILE SCALE DATE
SPUDTS8 NTS 7/22/04

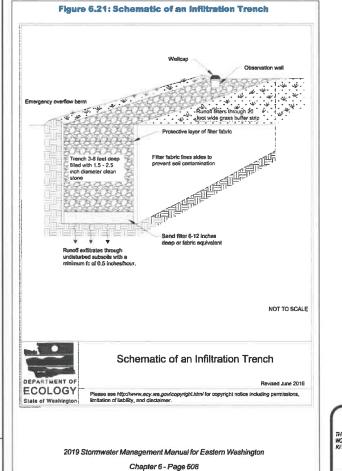

BRAVEL BACKFILL FOR PIPE ZONE BEDOING

SEPARATE BASE

### **KITTITAS COUNTY** APPROVED FOR CONSTRUCTION

DATE

DIRECTOR OF PUBLIC WORKS

Know what's below. Call before you dig.

03/08/2022

ACRES ESTATES LOTS SNOPASS SF LOFTS LLC UTILITY DETAILS SKI


> **S**oz Q NCOMPERING & SURV

> > 03/08/2022 NTS

DATE SCALE DESIGNED DRAWN CHECKED 8

SHEET

SW 1/4 OF SE 1/4 OF SECTION 9, T. 22 N., R. 11 E., W.M. KITTITAS COUNTY, STATE OF WASHINGTON

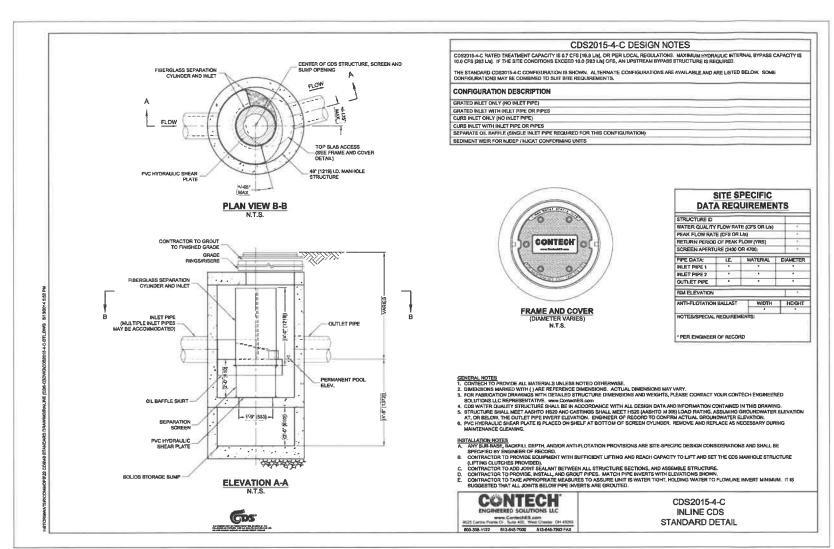





03/08/2022

6-11 SKI ACRES ESTATES LOTS SNOPASS SF LOFTS LLC UTILITY DETAILS



20264 03/08/2022 NTS IWD TNF CP CP

9

JOB NO. DATE SCALE

APPROVED


SHEET

**KITTITAS COUNTY** 

APPROVED FOR CONSTRUCTION
THESE PLANS HAVE BEEN REVIEWED BY NITHING COUNTY DEPARTMENT OF PUBLIC WORKS AND HAVE BEEN ACCEPTED FOR COMPLYING WITH THE REQUIREMENTS OF NITHING COUNTY.

DIRECTOR OF PUBLIC WORKS

Know what's below. Call before you dig.

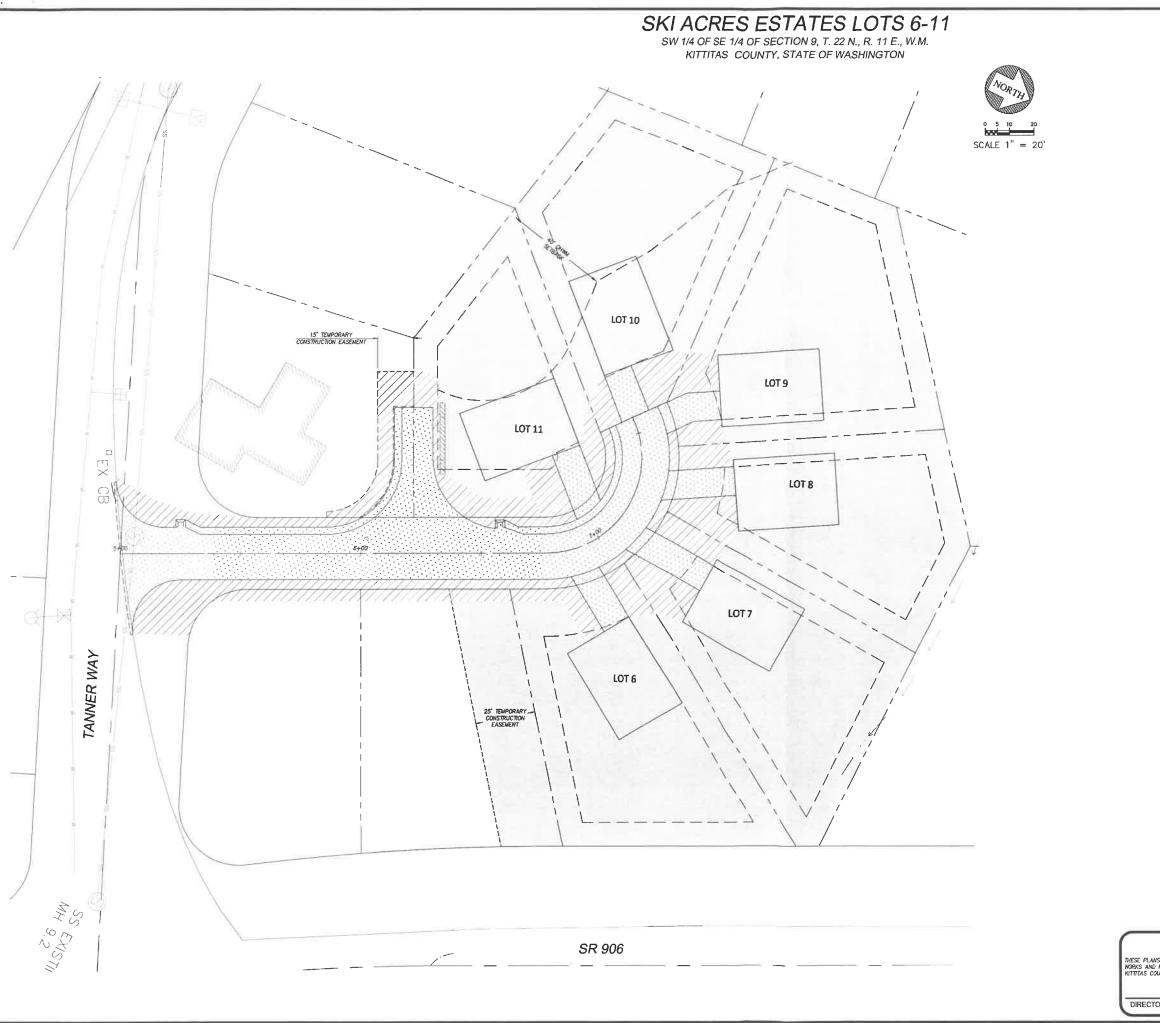



SNOW REMAINS IN-PLACE

SNOW STORAGE AREA

## SNOW REMOVAL CALCULATIONS

KITTITAS COUNTY

APPROVED FOR CONSTRUCTION
THESE PLANS HAVE BEEN REVIEWED BY KITHITAS COUNTY DEPARTMENT OF PUBLIC WORKS AND HAVE BEEN ACCEPTED FOR COMPLYING WITH THE REQUIREMENTS OF KITHITAS COUNTY.

DATE

DIRECTOR OF PUBLIC WORKS





SKI ACRES ESTATES LOTS 6-11 SNOW STORAGE PLAN

Encompass

20264 03/08/2022 1°=30' IWD TNF CP DESIGNED DRAWN CHECKED

10